

COMHAIRLE NAN EILEAN SIAR

The Town and Country Planning Scotland Act 1997 – Section 36(1)

Town and Country Planning General Development Procedure Order 2013 Regulation 16

Panning Register - Part 1

Application Details

Reference Number 24/00126/PPD Date registered as valid 22/03/2024

Description of Development Erect art studio. Create access and parking. (Amendment

to planning permission 23/00218/PPD)

Address or description of location to

which the development relates Studio, The Bungalow, Geocrab, Isle of Harris, HS3 3HB

Co-ordinates E 111 657 N 891 017
Applicant Name Ms Margaret Soraya

Applicant Address The Bungalow, Geocrab, Isle of Harris, HS3 3HB


Agent name (if applicable) Total Design Per Mr John Macleod
Agent address (if applicable) 22 Melbost, Isle of Lewis, HS2 0BG


The above application summary is accompanied by plans and drawings sufficient to describe the development and where relevant any design statement.

Important Note: on Tuesday 07 November 2023, Comhairle nan Eilean Siar experienced a criminal cyber incident and is working with Police Scotland, the Scottish Government and the National Cyber Security Centre to investigate the matter.

The Online Planning Portal remains unavailable as does our suite of integrated software and hardwaresystems. In order to enable access by the wider public to application documents and consult upon planning applications, interim systems have been put inplace on the temporary website of Comhairle nan Eilean Siar, including a rudimentary facility to display a limited number of documents per application.

Any party wishing to view the application file in full may do so at the offices of Comhairle nan Eilean Siar at Sandwick Road, Stornoway Isle of Lewis, HS1 2BW or Balivanich, Isle of Benbecula. HS7 5LA, ordinarily between 9am and 5pm Monday to Friday (excluding public and local holidays). It is recommended that in advance of visiting an office to view an application that you make an appointment by sending an email to planning@cne-siar.gov.uk

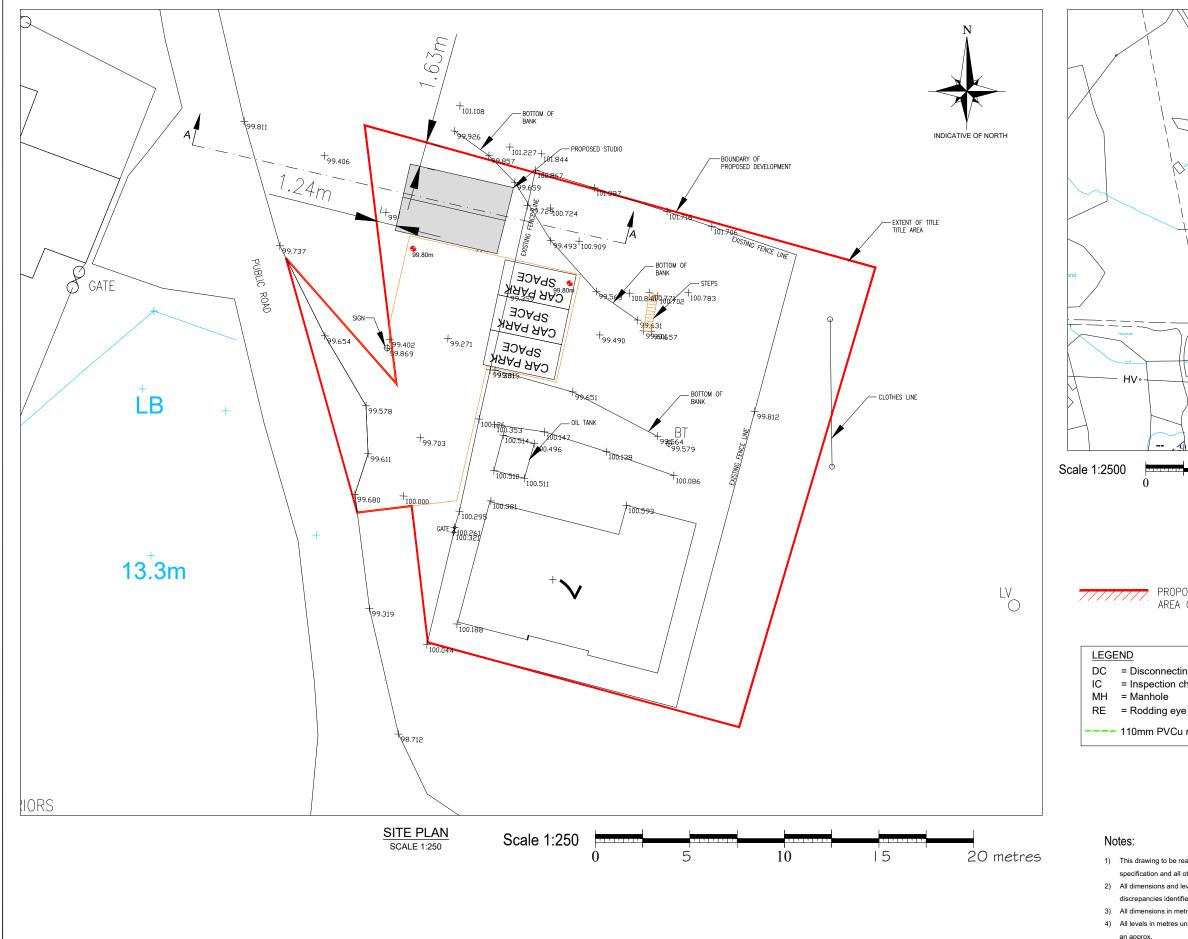

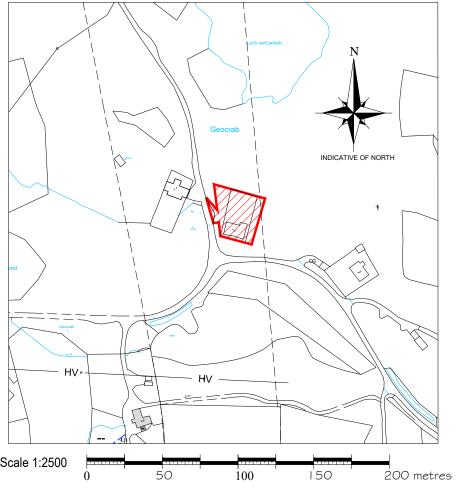

LOCATION PLAN

SCALE 1:2500

PROPOSED DEVELOPMENT SITE/ AREA OF LAND CONTROL

FOR APPROVAL

DC = Disconnecting chamber IC = Inspection chamber

MH = Manhole

--- 110mm PVCu rainwater pipe

TOTAL DESIGN (LIGHTHILL) LTD Balard, 68 Lighthill, Back, Isle of Lewis HS2 0LF Tel: 01851 820 998 Mob: 07917 806 013 Email: totaldesign@sky.com

Applicant:

Margaret Soraya

Proposed Art Studio The bungalow, Geocrab,
Isle of Harris

SITE PLAN AND LOCATION PLAN

Drawn by: J MacLeod	Date	: 20.04.23
Checked by:	Date:	
Approved by: -	Date: -	
Drawing No.		Revision
P855-P01		02
Drawing Scale: AS NOTED @ A3		

- 1) This drawing to be read in conjunction with the relevant specification and all other relevant drawings.
- 2) All dimensions and levels to be checked on site and any discrepancies identified prior to commencement of work.
- 3) All dimensions in metres unless otherwise noted.
- 4) All levels in metres unless otherwise noted. Levels relative to an approx.
- 5) It is the responsibility of the applicant to inform landowners and seek the necessary permission(s) for the proposed foulwater route.
- 6) It is the responsibility of the applicant/owner to undertake the necessary trial holes to establish if ground conditions are suitable along the extent of the foulwater pipe line.



GENERAL NOTES:

1. ALL CLADDING TO BE CE MARKED AND HOT-DIP GALVANISED TO BS EN 10346:2009.


2. ALL STEEL (INCLUDING PURLINS) TO BE CE MARKED AND TO EXECUTION CLASS 2 AS PER EN 1090 - 1:2009 AND HOT-DIP GALVANISED TO BS EN 10346:2009 Fe E390G-Z275. 3. DESIGN LOADS TO BS 6399-1:1997 AND BS 6399-3:1997. DEAD LOADS: SW CONSIDERED INTERNALLY WITHIN PROGRAMME


- -CEILINGS AND SERVICES = kN/m2
- -RAFTER CLADDINGS AND PURLINS = kN/m2
- -COLUMN CLADDINGS AND RAILS = kN/m2 -SNOW LOAD = kN/m2
- -LIVE LOAD = kN/m2

6399-2:1997 WITH THE FOLLOWING
PARAMETERS:
BASIC WIND SPEED = m/s
SITE ALTITUDE = m
SITE ALTITUDE FACTOR =
SEASONAL FACTOR = DIRECTION FACTOR =
SITE DISTANCE FROM SEA = 10-100 km

5.ALL STEEL TO HAVE YIELD STRENGTH Py = 450 MPa.

4. WIND LOAD ACCORDING TO BS

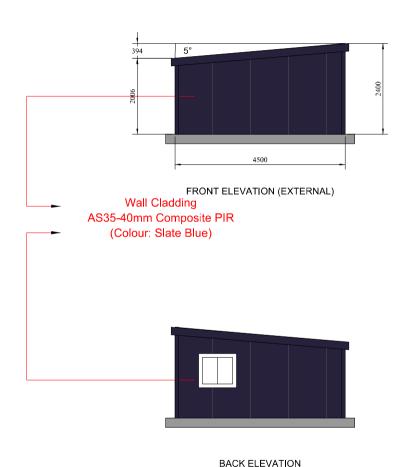

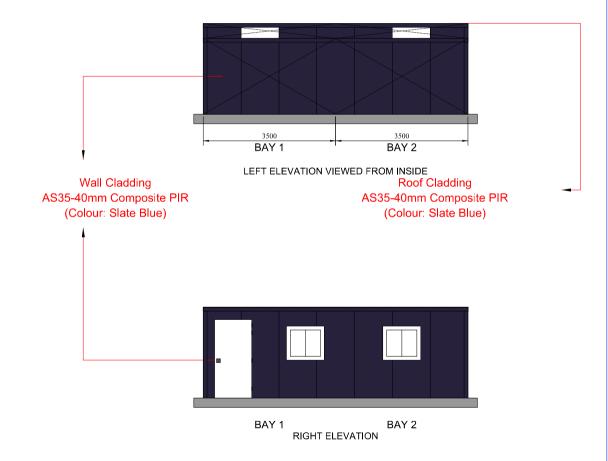

DESIGN SUPPLIED BY: GRAMPIAN STEEL BUILDINGS LTD

ADDRESS: THE SHOW SITE ,2 UGIE ROAD ,PETERHEAD ,ABERDEEN

EMAIL: ROBERT@GRAMPIANSTEELBUILDINGS.CO.UK

PHONE: +44 1779 480 700

CLIENT: MARGARET SORAYA

ADDRESS: ,ABHAINN RUADH,GEOCRAB,ISLE OF HARRIS,HS3 3HB

EMAIL: INFO@SORAYAPHOTO.COM

PHONE: N/A - 07709364265

DRAWING TITLE: ELEVATION ALL

DRAWING REVISION NUMBER: 00

SCALE: 1:100



GENERAL NOTES

1. ALL CLADDING TO BE CE MARKED AND HOT-DIP GALVANISED TO BS EN 10346:2009.

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-COLUMN CLADDINGS AND PURLINS = kN/m2
-COLUMN CLADDINGS AND RAILS = kN/m2
-SNOW LOAD = kN/m2

-LIVE LOAD = kN/m2

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SITE ALTITUDE = m SITE ALTITUDE FACTOR =

SEASONAL FACTOR = DIRECTION FACTOR =

SITE DISTANCE FROM SEA = 10-100 km

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C Sections 200mm wide x 2mm thick Left Side Column Centres Sections 150mm wide x 20mm thick 쑹 0 \circ Sections SGC (GC)⊊ (IC ctions 6494 201 End wall mullions (Internal Length) 150mmWlde x 20mm 150mm wide x 20mm thick × Span) ctions 150mBWMide Slab as per structural Wall Columbas Moon wall mullions Back sul bajang randatails22 (Internal End Intermediate columns C Sections 200mm wide x 2mm thick **∃**(GC) O 3500 3500 BAY 1 BAY 2 7000 Right Side

Intermediate columns

IC: INTERMEDIATE COLUMN

GC: GABLE COLUMN

GWM: GABLE WALL MULLION

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CLIENT: MARGARET SORAYA

ADDRESS: ,ABHAINN RUADH,GEOCRAB,ISLE OF HARRIS,HS3 3HB

SCALE BAR:

EMAIL: INFO@SORAYAPHOTO.COM

PHONE: N/A - 07709364265

DRAWING TITLE: FLOOR PLAN

DRAWING REVISION NUMBER: 00

SCALE: 1:75

DESIGN STATEMENT

Applicant: Margaret Soraya

Site: The Bungalow Geocrab, Isle of Harris

CONTEXT

The Bungalo, Isle of Harris is located within the 'South Lewis, Harris and North Uist Scenic Area'. This design statement is to accompany the detailed planning application for a proposed building.

The proposed development site is located on the applicant's garden ground at The Bungalow Geocrab, Isle of Harris. The development site on the East side of the public road. The building will be set back approximately 8.5 metres from the edge of the road.

SITE DESCRIPTION

The proposed site lies to the East of the public access road in the village of Geocrab.

The proposed development site is in an area of relatively flat unused garden ground

The principal elevation will face south west.



Figure 2 – View looking South West from proposed development site

To create a level platform for the building a small amount of fill will be required. The building finished floor level has been selected so as to minimise the amount of imported fill required.

DEVELOPMENT ON THE SITE

The proposed building generally meets the criteria of the Outer Hebrides design guide. The proposed building has been designed to be sympathetic to the site and the surroundings.

The proposed building follows the design advice presented in the 'Outer Hebrides Design Guide'. For example: -

• The roof is mono-pitch, with no projecting features

- The walls will be slate blue insulated composite metal cladding
- The roof will be slate blue insulated composite metal cladding
- The building will be sited to avoid any excessively exposed under building

SERVICES & SURFACEWATER

Public utilities do not adversely impact on the development of the site. The building does not have a water or foul connection. Surface water run-off will be directed into a croft ditch. All areas excavated for the installation of services will be landscaped on completion with original turf reinstated.