

COMHAIRLE NAN EILEAN SIAR

The Town and Country Planning Scotland Act 1997 – Section 36(1)

Town and Country Planning General Development Procedure Order 2013 Regulation 16

Panning Register - Part 1

Application Details

Reference Number 24/0014/PPD Date registered as valid 22/03/2024

Description of Development Formation of access track

Address or description of location to

which the development relates Scottish Water Access Track, Balallan, Lochs, Isle Lewis

Co-ordinates E 129 718 N 920 400

Applicant Name Scottish Water Per Mr Martin Walker
Applicant Address 56 Buckstone Terrace, Edinburgh, EX10 6XH


Agent name (if applicable)
Agent address (if applicable)

The above application summary is accompanied by plans and drawings sufficient to describe the development and where relevant any design statement.

Important Note: on Tuesday 07 November 2023, Comhairle nan Eilean Siar experienced a criminal cyber incident and is working with Police Scotland, the Scottish Government and the National Cyber Security Centre to investigate the matter.

The Online Planning Portal remains unavailable as does our suite of integrated software and hardwaresystems. In order to enable access by the wider public to application documents and consult upon planning applications, interim systems have been put inplace on the temporary website of Comhairle nan Eilean Siar, including a rudimentary facility to display a limited number of documents per application.

Any party wishing to view the application file in full may do so at the offices of Comhairle nan Eilean Siar at Sandwick Road, Stornoway Isle of Lewis, HS1 2BW or Balivanich, Isle of Benbecula. HS7 5LA, ordinarily between 9am and 5pm Monday to Friday (excluding public and local holidays). It is recommended that in advance of visiting an office to view an application that you make an appointment by sending an email to planning@cne-siar.gov.uk

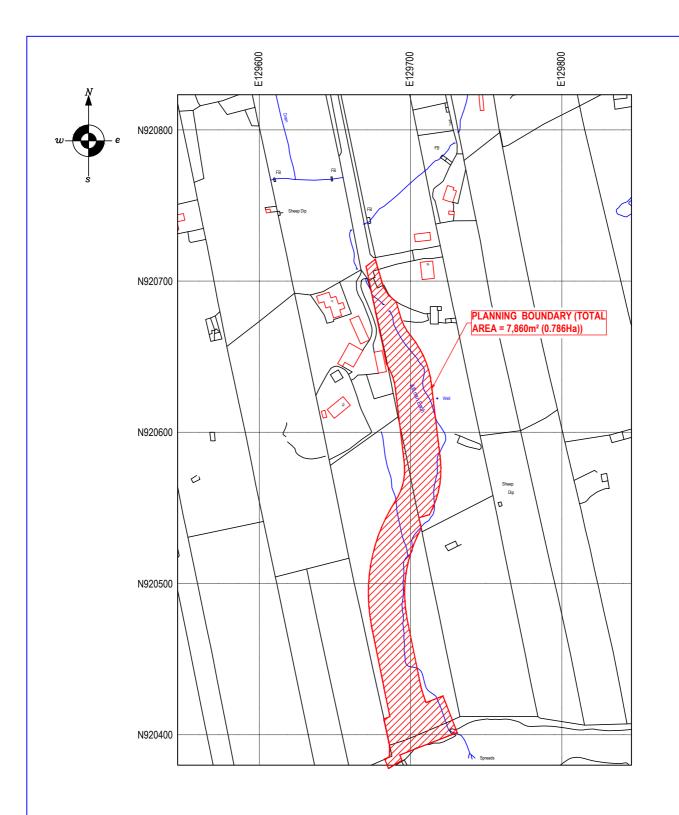



Site Location Plan


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Site Centred Co-ordintates N.G.R. NB 129720,920405


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\$	SERVICES EM	TEL (01851) 704703 EMAIL malcolm@maciverconsultancy.com						
			REV.	REVISION NOTE		DATE	INITIALS	
SCHEME :			SCALE(S):		DATE:	FEBRUARY	2024	
BALALLAN EAST SEPTIC TANK			1:2500 @ A4		DRAWN:	SMI		
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TITLE:	SITE LOCATION PLAN			DRAWING NO.: 23/97/04 PLANNING				




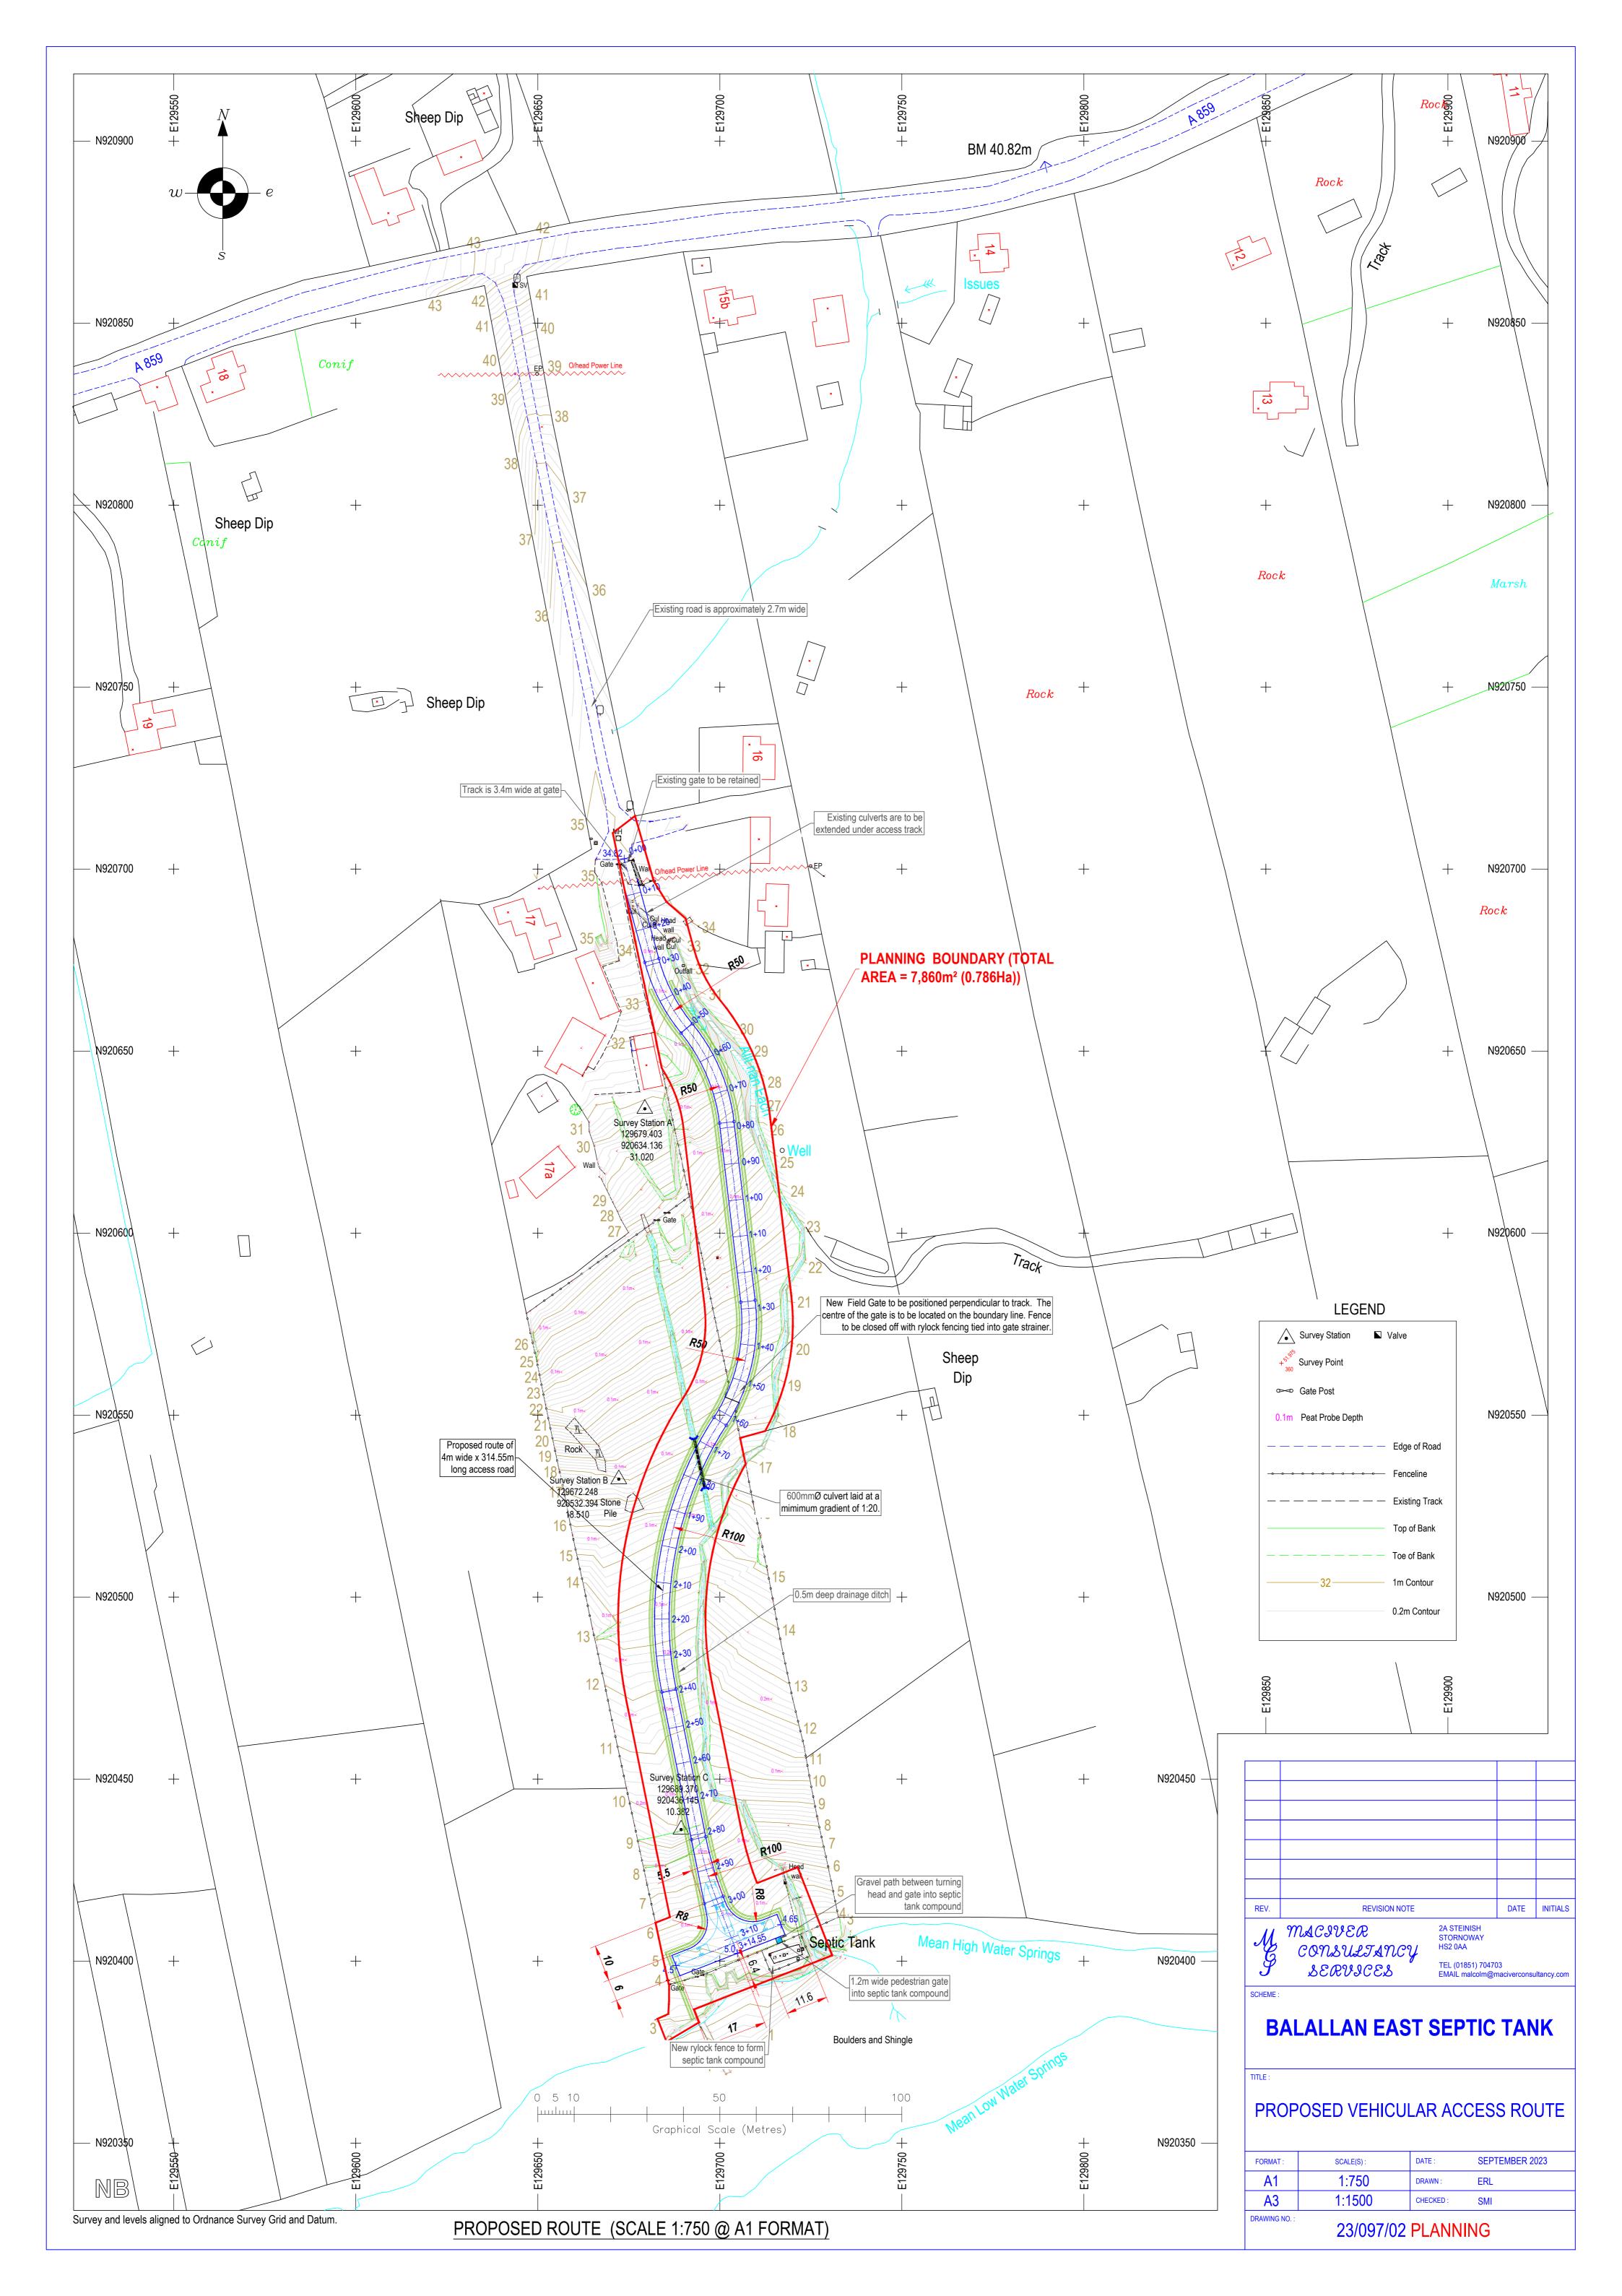

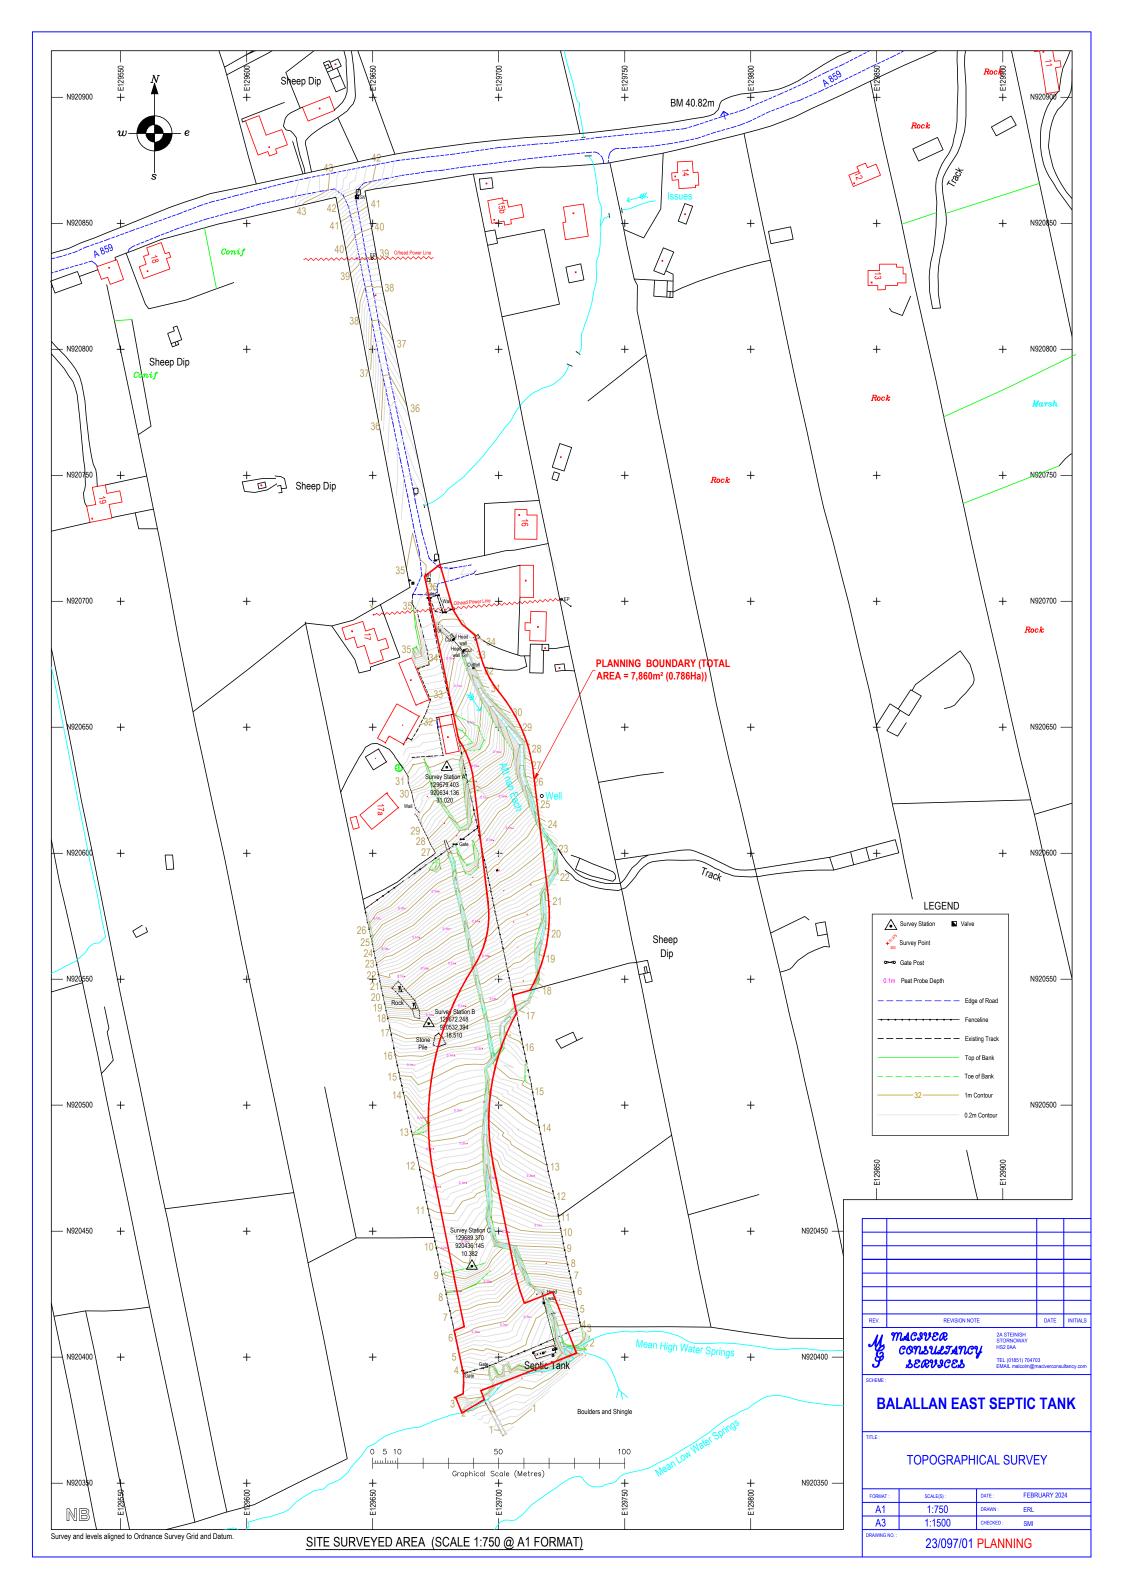

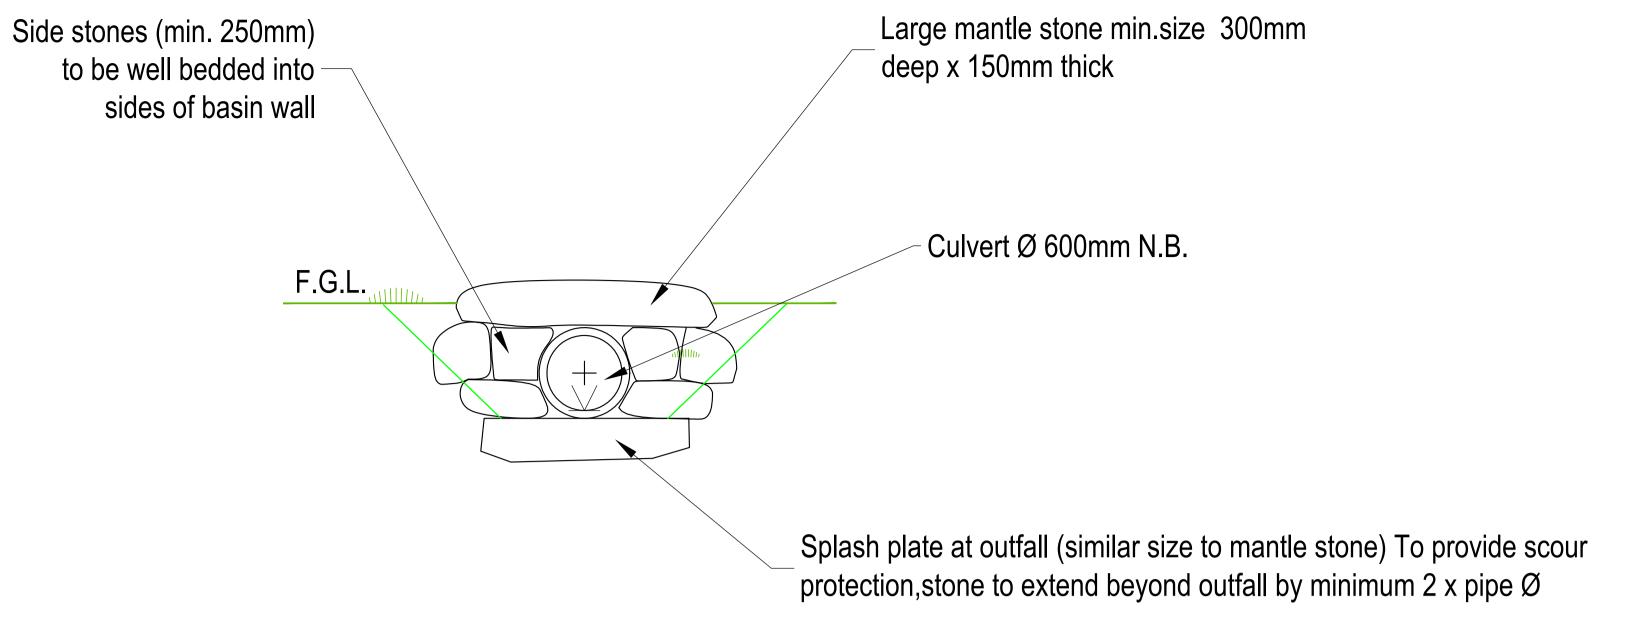TYPICAL MASONRY HEADWALL CULVERT INLET & DISCHARGE (1:25@A1)

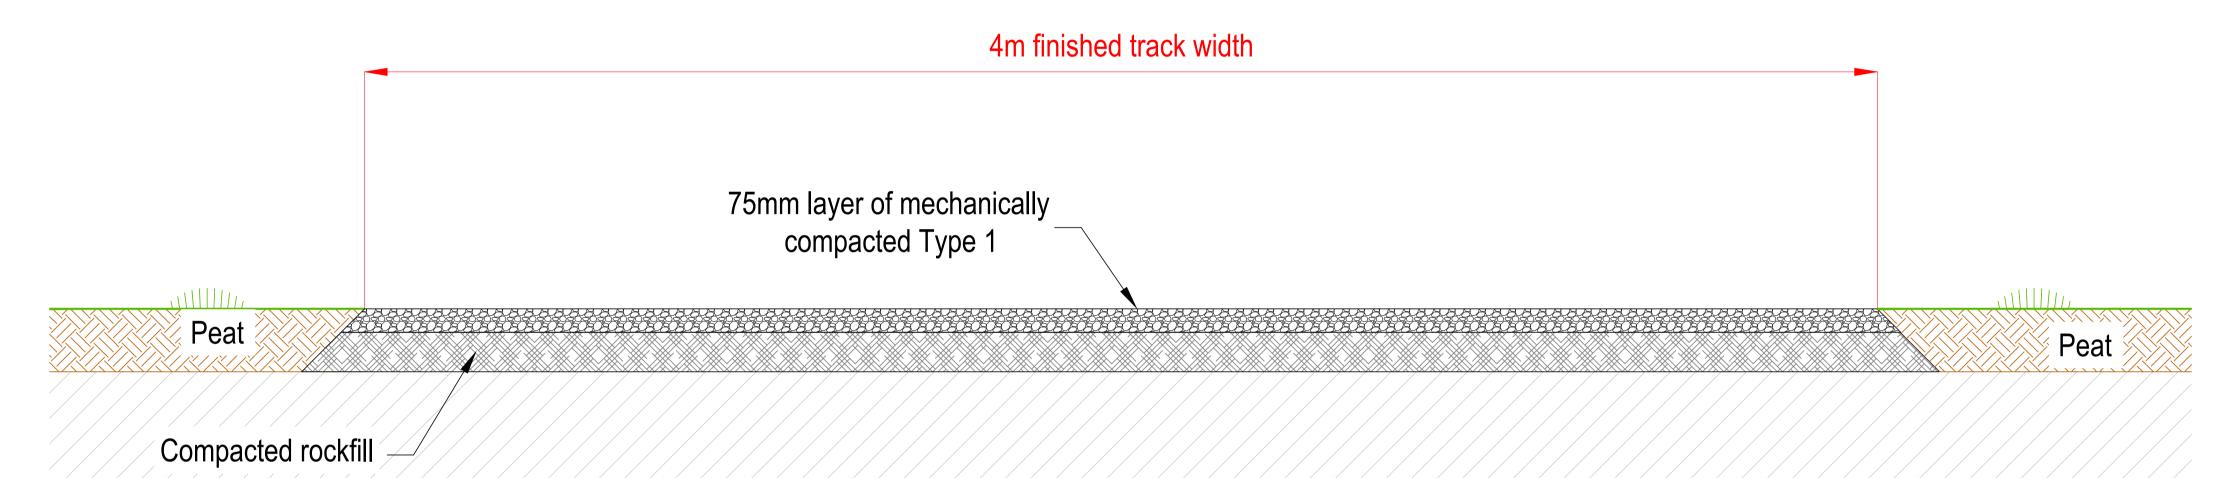

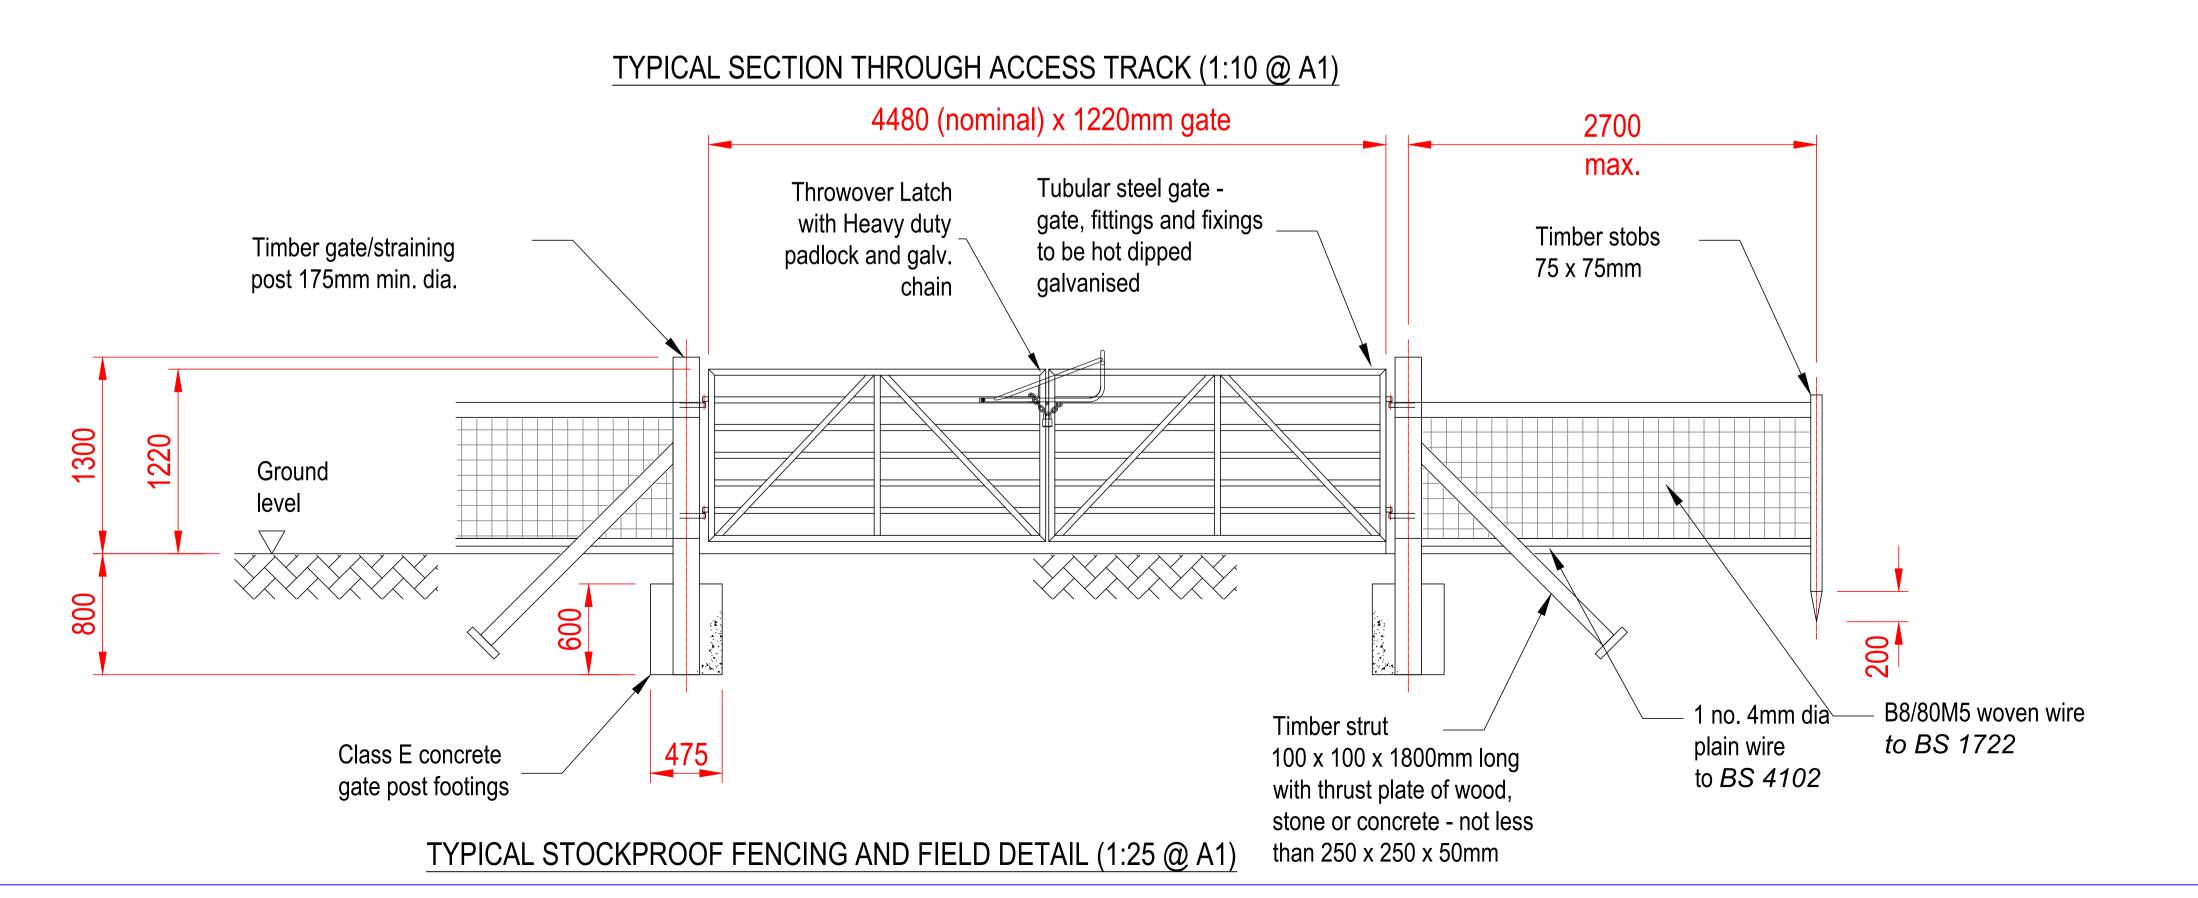


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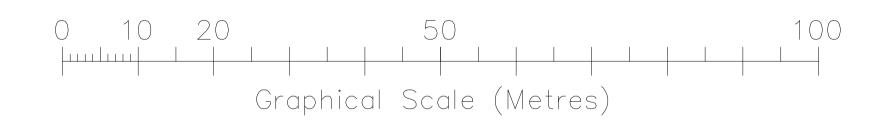
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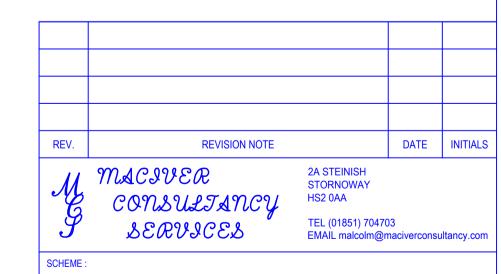
STANDARD DETAILS	

DRAWING NO. :	1:50 1:20	5 PLANN	MMI
A1	1:25 1:10	DRAWN:	SMI
FORMAT:	SCALE(S):	DATE:	DECEMBER 2023



PROPOSED ACCESS LONGITUDINAL SECTION (SCALE 1:500 @ A1 FORMAT)



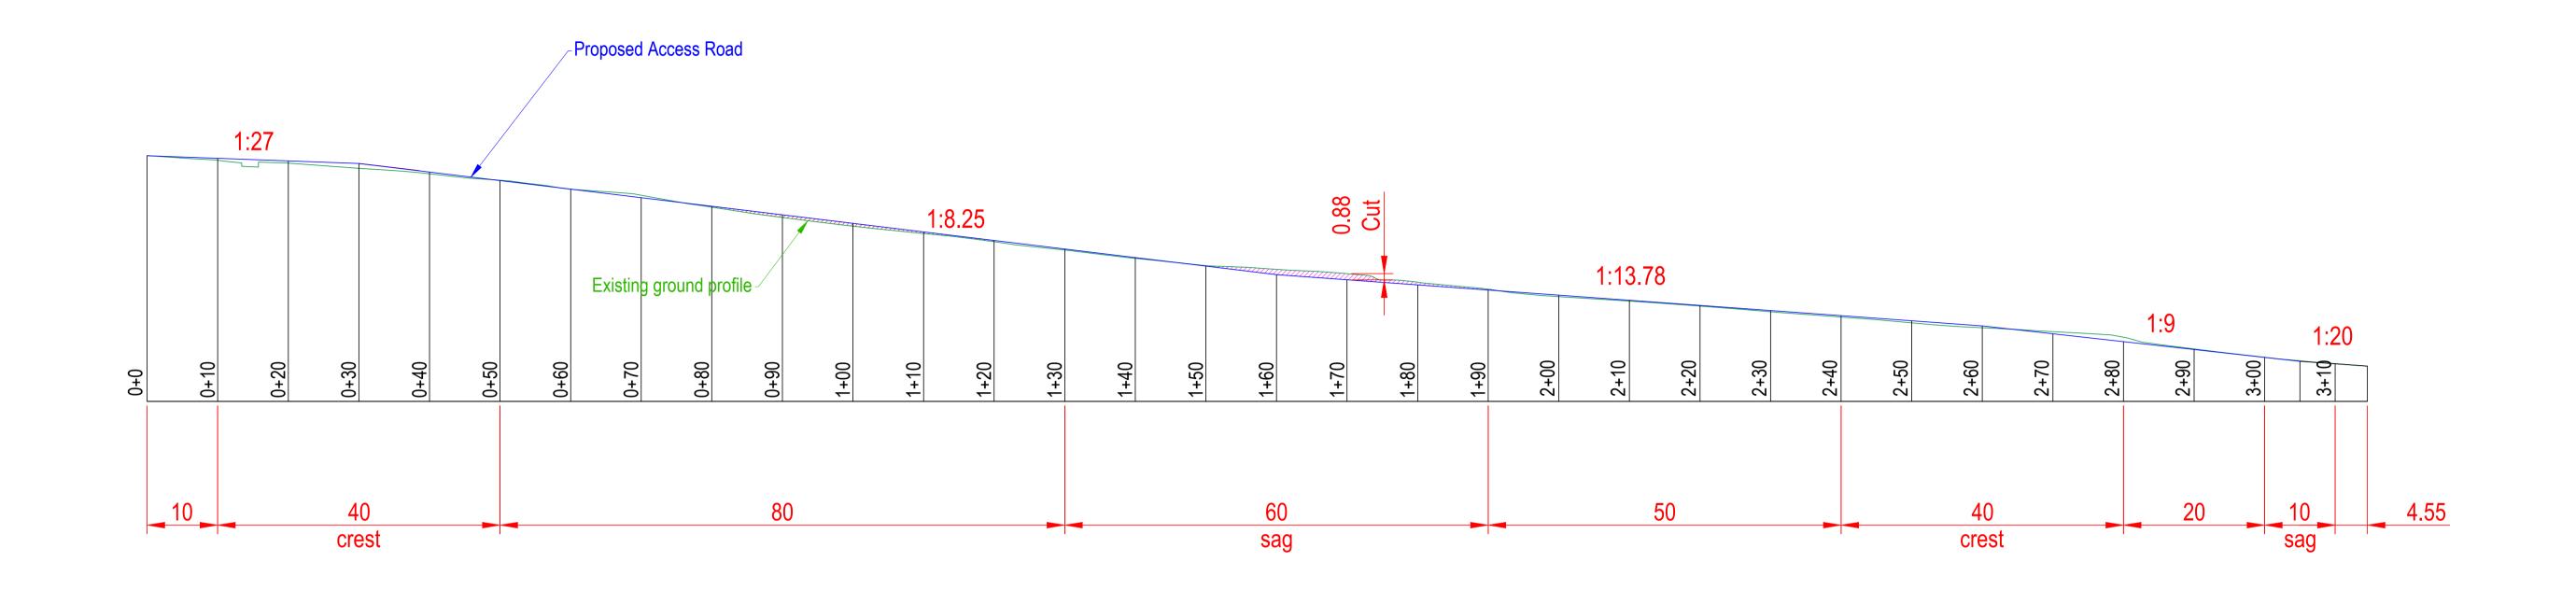

BALALLAN EAST SEPTIC TANK

TITLE :

PROPOSED VEHICULAR ACCESS ROUTE LONGITUDINAL SECTION

A3	1:1000	CHECKED:	SMI
A1	1:500	DRAWN:	ERL
FORMAT:	SCALE(S):	DATE:	OCTOBER 2023

SUPPORTING STATEMENT



Application Site: Balallan East Septic Tank

Application Description: Formation of Access Track

Date: March 2024

PROJECT DESCRIPTION

Scottish Water require a new access to the existing Balallan East septic tank to enable desludging and safe access for operatives carrying out routine maintenance.

SITE DESCRIPTION

The existing Balallan East septic tank (Grid Reference NB 29718 20400) is located approximately 1.5km south east of Balallan village. The application site is bound to the north by residential dwellings, to the east and west by agricultural land and to the south by Loch Eireasort. The land falls from north to south towards the loch.

The site of the proposed works is an area of agricultural grassland, situated between the septic tank and residential dwellings to the north. There is no formal access at present between the nearest dwellings and the septic tank, which is separated by a distance of approximately 250m. The dwellings to the north are served by a private access road off the A859, which is approximately 470m north of the septic tank.

There are no environmental constraints or designations affecting the site with respect to flood risk, protected species, built heritage and core paths. The surrounding agricultural land is not classified as prime agricultural land.

PROPOSED DEVELOPMENT

The proposed access track will connect the existing septic tank adjacent to Loch Eireasort and the existing access road serving the dwellinghouses and agricultural buildings approximately 250m to the north. The track will have a total length of approximately 315m and a width of 4m. The route will be formed of a 75mm layer of crushed aggregate stone. A single field gate will also be installed at the halfway point of the track. New rylock fencing will also be formed around the existing septic tank compound.

PLANNING POLICY

Under Section 25 of the Town and Country Planning (Scotland) Act 1997, the proposed

development stands to be determined against the policies contained within the development plan,

unless material considerations indicate otherwise. The extant development plan for the area is:

National Planning Framework 4 (NPF4)

Outer Hebrides Local Development Plan (2018)

National Planning Framework 4

National Planning Framework 4 (NPF4) is the national spatial strategy for Scotland. NPF4 sets

out spatial principles, regional priorities, national developments and national planning policy. The

following national planning policies are considered relevant to the proposal:

Policy 4: Natural Places

Policy 14: Design, quality and place

Policy 18: Infrastructure First

• Policy 29: Rural Development

Outer Hebrides Local Development Plan (2018)

The following policies within the Outer Hebrides Local Development Plan (OHLDP) (2018) are

applicable to the proposal:

Policy El 9: Transport Infrastructure

Policy PD1: Placemaking and design

Policy NHB1: Landscape

PLANNING ASSESSMENT

Principle of Development

NPF4 Policy 29 Rural Development encourages rural economic activity, innovation and

diversification. Development proposals that contribute to the viability, sustainability and diversity

of rural communities and local rural economy will be supported, including essential infrastructure.

Policy 18 Infrastructure First of NPF4 does not specifically refer to water or wastewater

infrastructure, however the intention of this policy is to encourage, promote and facilitate an

infrastructure first approach to land use planning, which puts infrastructure at the heart of

SW Internal General

placemaking. Policy EI9 Transport Infrastructure of the OHLDP supports proposals for improved infrastructure, on the basis that it would not detract from the character of the area.

The proposal seeks to form a new access track to provide a formalised, safe access to the Balallan East septic tank. The track is essential to enable operatives to carry out routine maintenance. The principle of an access track in this location is considered to be acceptable as it will serve the existing septic tank and will effectively be a continuation of an existing road. The proposed access is in keeping with the character of the area, which includes other access tracks of a similar scale and layout serving dwellinghouses and agricultural units. The proposal is therefore considered to comply with NPF4 Policy 18, 29 and OHLDP Policy EI9 and is acceptable in principle.

Landscape

NPF4 Policy 4 Natural Places and OHLDP 2018 Policy NBH1 Landscape seeks to protect the visual quality of landscapes and the integrity of the landscape character.

The proposed works would not have a significant adverse impact on the character of the landscape. The access track slopes downwards from north to south towards the loch and would not be highly visible from public viewpoints or the public road A859. There are several other tracks in the nearby area which are orientated in a similar direction from north to south towards the loch. The development will not require a significant amount of engineering works and will be built into the natural topography of the landscape. Overall, due to the design, scale and layout of the proposed access track, it would not have an adverse effect on the character of the landscape. The proposal is therefore considered to comply with NPF4 Policy 4 and OHLDP 2018 Policy NBH1.

Layout, siting and design

NPF4 Policy 14 Design, quality and place requires development proposals to improve the quality of an area whether in urban or rural locations and regardless of scale. OHLDP 2018 Policy PD1 Placemaking and design requires development proposal to demonstrate a satisfactory quality of place-making, siting scale and design that respects and reflects local characteristics and the surrounding built and natural environment.

The proposed access track is of an appropriate scale and design for the character of the area, with a maximum width of approximately 4m connecting an existing road and septic tank. The

access has been designed taking into account the natural topography of the land and therefore would not have a significant visual impact on the wider landscape. The access track will be formed of crushed aggregate material and is suitable for the context of the area. The development will improve the quality of the area by creating a safe access to the septic tank, allowing operations and maintenance to be carried out safely. This will provide a wider overall benefit of improved wastewater treatment for the village of Balallan. Overall, the proposal is considered to comply with NPF4 Policy 14 and OHLDP 2018 Policy PD1.

CONCLUSION

Under Section 25 of the Town and Country Planning (Scotland) Act 1997, the proposed development stands to be determined against the policies contained within Outer Hebrides Local Development Plan 2018 and National Planning Framework 4, unless material considerations indicate otherwise. The relevant planning policies have been assessed and it is considered that the proposed development is compliant with all applicable policies. The planning application is submitted with supporting information in the form of site plans, section drawings, and technical specification. The proposed development would ensure safe access to the existing septic tank, whilst being mindful of the existing landscape character and minimising any impacts on this.

Additional Application Documents:

Drawings:

- 1. Topographical Survey
- 2. Proposed Access Route
- 3. Proposed Access Route Long Section
- 4. Site Location Plan
- 5. Sections and elevations